

FLOOR SLAB EXTENDED ON GRADE AS SHOWN TO SUPPORT BUILDING OVER - TO ENGINEERS DETAILS


TREATED TIMBER ENTRANCE FRAME STRUCTURE TO ENGINEERS SPECIFICATION

750mm Deep TANK ROOF SLAB (250mm SCREED ON 500mm FC SLABS)
FFL 54.68

FLOOR SLAB EXTENDED ON GRADE AS SHOWN TO SUPPORT BUILDING OVER - TO ENGINEERS DETAILS

SSL SLAB FOR SUBSTATION AT -900mm BELOW FFL TO ALLOW BUILD-UP OF DUCTING. SUBSTATION TO BE CONSTRUCTED IN ACCORDANCE WITH ESB SPEC. 13320 rev 7

LINE OF TANK WALL UNDER

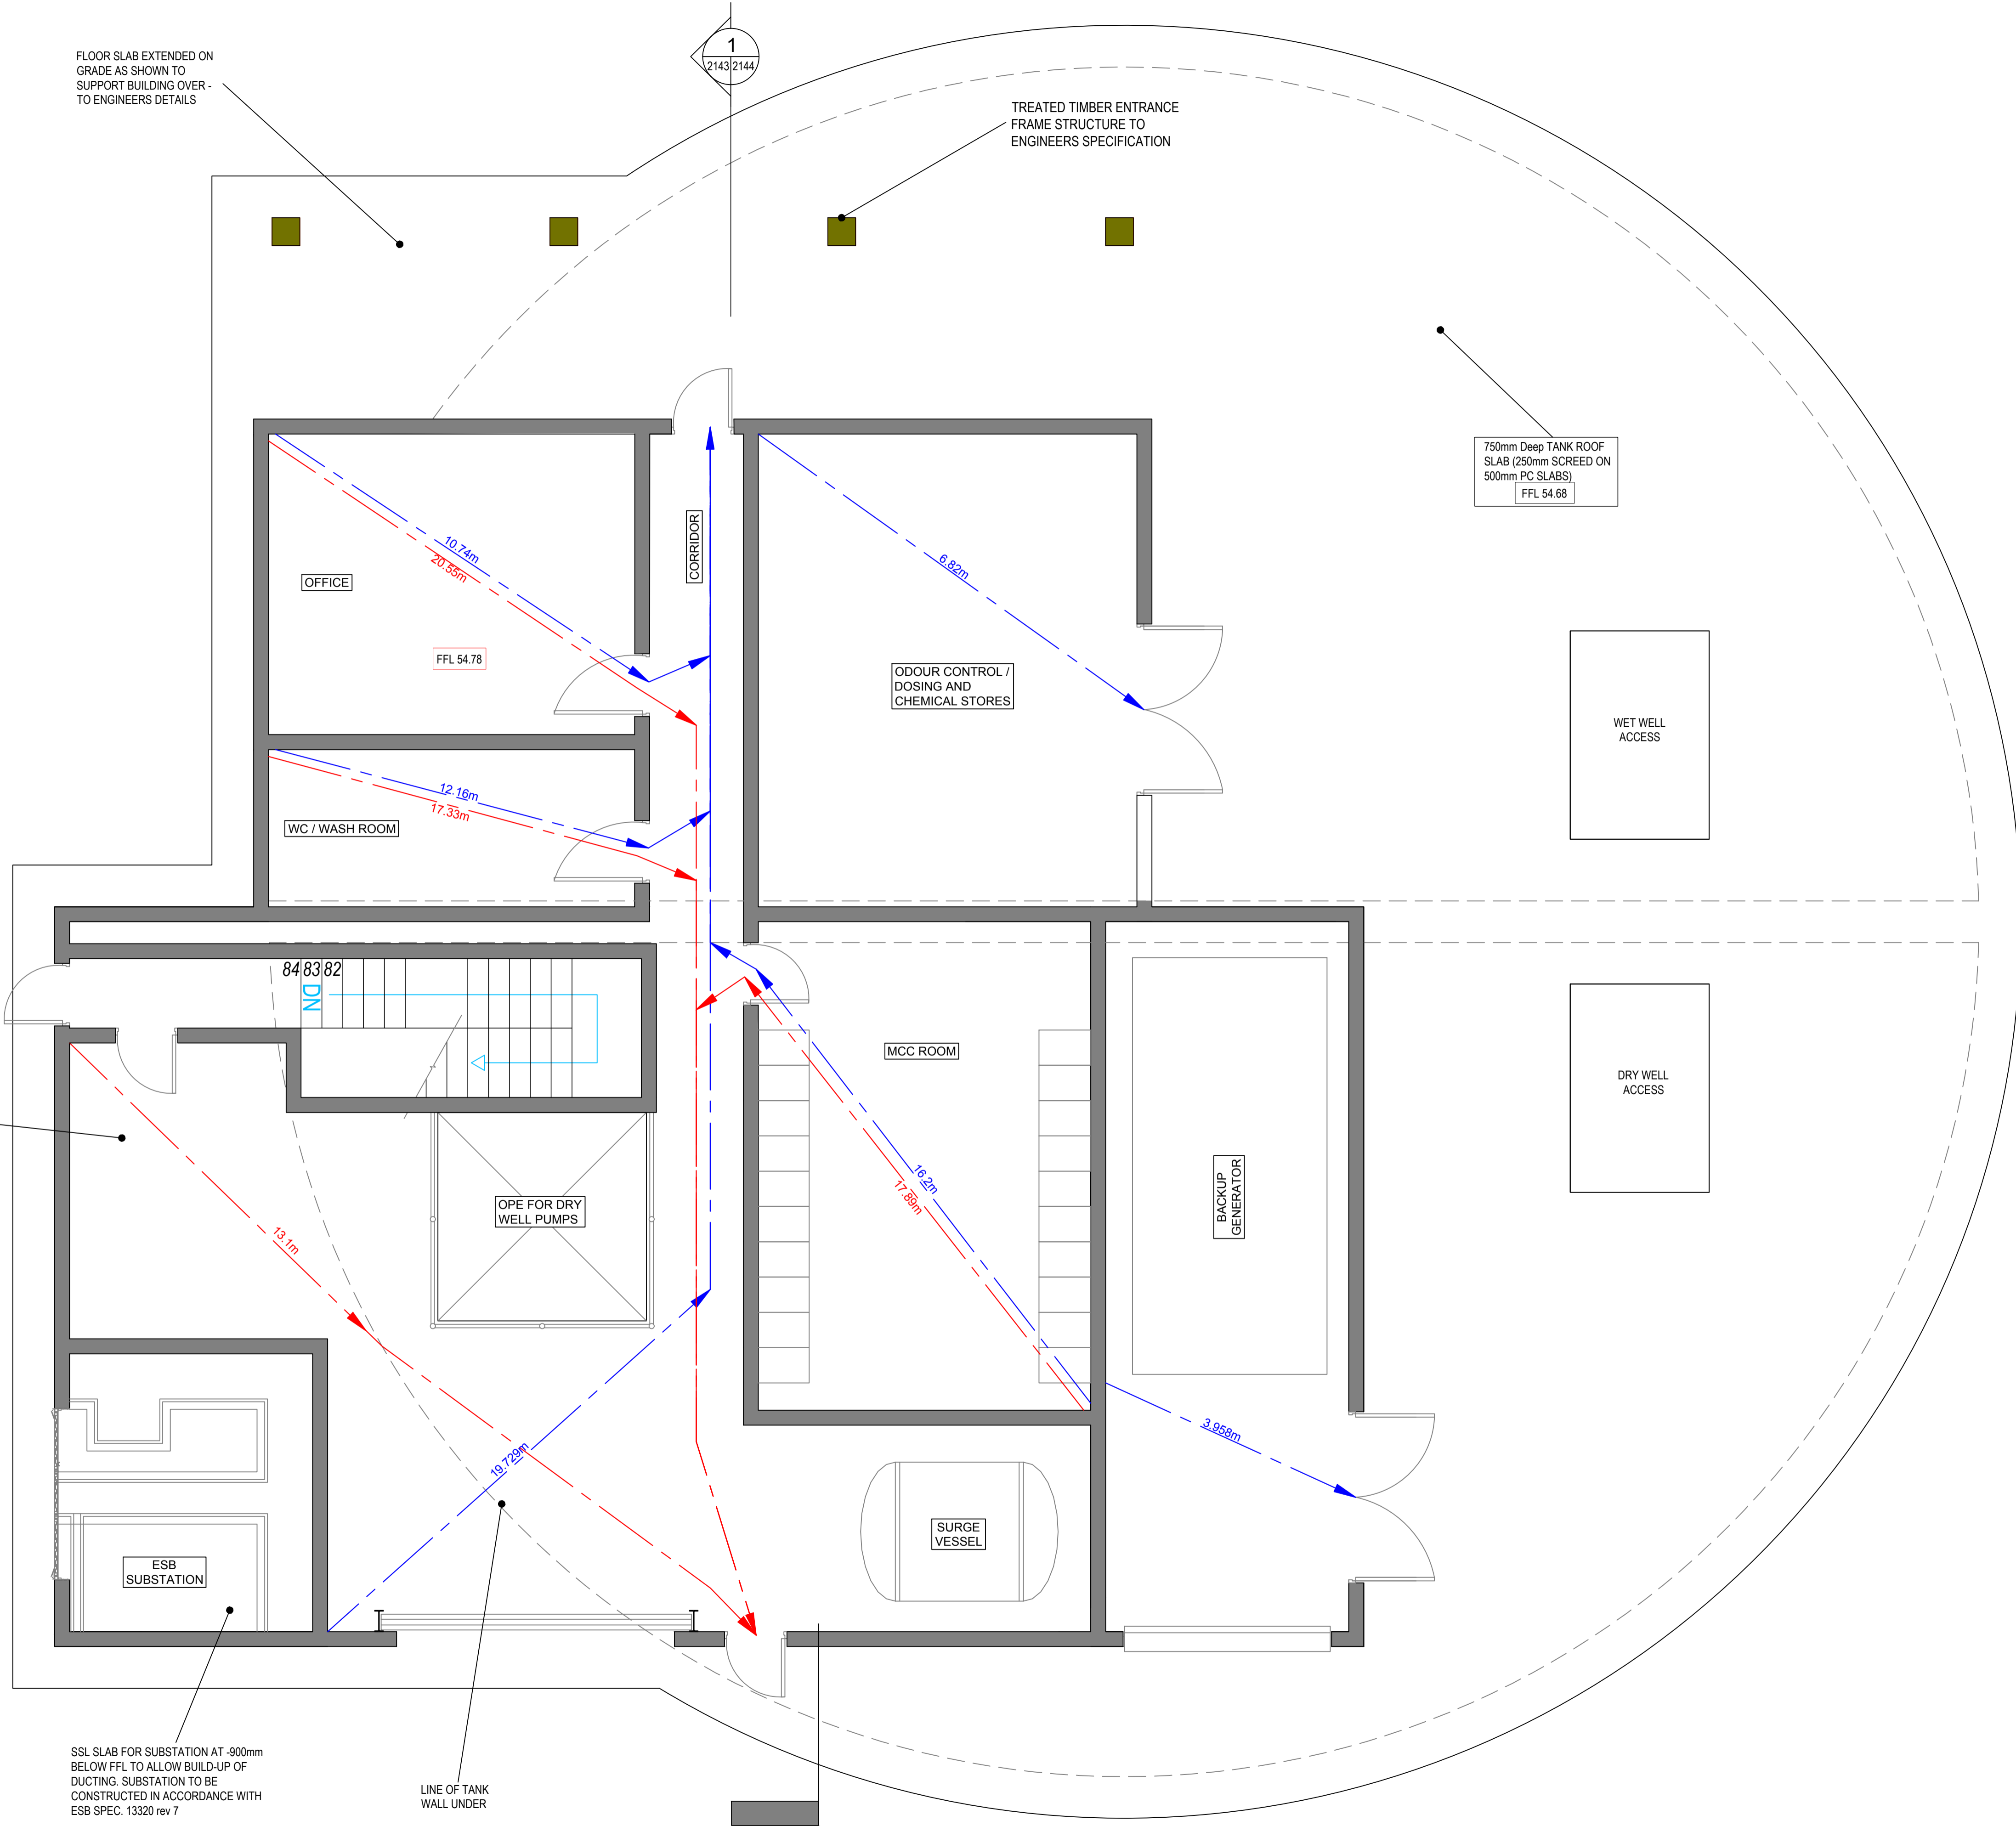

LEGEND:

- TRAVEL DISTANCE 1 - - - - - ▶
- TRAVEL DISTANCE 2 - - - - - ▶

NOTES:

1. FIGURED DIMENSIONS ONLY TO BE TAKEN FROM THIS DRAWING.
2. ALL DRAWINGS TO BE CHECKED BY THE CONTRACTOR ON-SITE.
3. ENGINEER/EMPLOYERS REPRESENTATIVE, AS APPROPRIATE, TO BE INFORMED BY THE CONTRACTOR OF ANY DISCREPANCIES BEFORE ANY WORK COMMENCES.
4. THE CONTRACTOR SHALL UNDERTAKE A THOROUGH CHECK FOR THE ACTUAL LOCATION OF ALL SERVICES/UTILITIES, ABOVE AND BELOW GROUND, BEFORE ANY WORK COMMENCES.
5. ALL LEVELS SHOWN RELATE TO ORDANCE SURVEY DATUM AT MALIN HEAD.

Rev	Date	Description	By	Chkd.
P01	08.06.18	ISSUE FOR PLANNING	AOC	BD

Client:

Project:

Title: **ABBOTSTOWN PUMPING STATION FIRE SAFETY REVIEW**

Scale @ A1: 1:50

Prepared by: A. O'Callaghan Checked: B. Downes Date: June 2018

Project Director: C. O'Keefe

Drawing Status: Planning

Tobin Consulting Engineers will not be liable for any use of this document for any purpose other than that for which it was originally prepared and provided. Client's name, specification and liability agreed in writing by Tobin Consulting Engineers. No copyright notice is part of this document and no reproduction or translation in any form or by any means, electronic, mechanical, photocopying, recording, or by any information storage and retrieval system, is permitted without the prior written permission of the copyright owner. This document is the property of the copyright owner and is loaned to the client for their use only. It is not to be distributed to any other party for any purpose.

Drawing No.: 32102900-2146 P01

GROUND FLOOR PLAN (TANK ROOF)
SCALE 1:100